

## AIRFLOW CONTROL VALVE (ACV), CONTROL SEQUENCE:

- A. EACH <u>ACV</u> SHALL BE PROVIDED WITH A FACTORY PROGRAMMED DEDICATED DDC CONTROLLER
  TO IMPLEMENT THE SEQUENCE OF OPERATION DESCRIBED BELOW:
  (1. THE VALVE CFM SHALL BE FIELD ADJUSTABLE.
  - (2. THE VALVE SHALL MODULATE TO MAINTAIN THE SCHEDULED CFM INDEPENDENT OF THE SYSTEM PRESSURE.
  - (3. THE HIGH AND LOW LIMIT FOR THE <u>ACV</u> SHALL BE SET TO +-10% (ADJ) OF THE SCHEDULED CFM.
     B. <u>1-EF5A</u> SHALL RUN CONTINUOUSLY. INSTALL CURRENT SENSORS ON EXHAUST FAN <u>1-EF5A</u>.
- UTILIZE THE FAN CURRENT SENSORS TO MONITOR THE FAN.

  C. 1-EF3 SHALL RUN CONTINUOUSLY. INSTALL CURRENT SENSORS ON EXHAUST FAN 1-EF3. UTILIZE THE FAN CURRENT SENSORS TO MONITOR THE FAN.

  2. SYSTEM GRAPHICS: THE SYSTEM GRAPHICS SHALL DISPLAY ALL POINTS INDICATED ON THE CONTROL SCHEMATIC AND THE FOLLOWING ITEMS:
- A. CFM SETPOINT FOR EACH <u>ACV</u>.
  B. CFM THROUGH EACH <u>ACV</u>.
- C. TOTAL CFM FOR ALL ACV SERVED BY A SINGLE FAN.
  D. HIGH/LOW LIMIT CFM SETPOINT FOR EACH ACV. AN ALARM SHALL BE SET AT THE OPERATORS WORKSTATION IF THE CFM RISES ABOVE OR FALLS BELOW THE HIGH/LOW LIMIT CFM SETPOINT.
  E. GENERAL ALARM. AN ALARM SHALL BE SET AT THE OPERATORS WORKSTATION IF THERE IS A GENERAL FAULT IN THE CONTROLLER, JAMMED LINKAGE OR A SENSOR FAILURE AS APPLICABLE.
  F. STATUS OF FAN 1-EF5A.
- G. STATUS OF FAN 1-EF3.

  H. IF THE FAN SERVING THE <u>ACV</u> IS ON, THE <u>ACV</u> STATUS SHALL BE DISPLAYED AS ENABLED AT THE OPERATORS WORKSTATION.

  I. IF THE FAN SERVING THE <u>ACV</u> IS OFF, THE <u>ACV</u> STATUS SHALL BE DISPLAYED AS DISABLED AT
- THE OPERATORS WORKSTATION.

  J. THE DIFFERENTIAL PRESSURE MEASURED ACROSS FILTER HF-5A:

  (1. PROVIDE A YELLOW MAINTENANCE WARNING WHEN THE DIFFERENTIAL PRESSURE EXCEEDS 0.7 INCHES (ADJ.) FOR THE PREFILTER AND 1.3 INCHES (ADJ.) FOR THE FINAL
- (2. PROVIDE A RED MAINTENANCE WARNING WHEN THE DIFFERENTIAL PRESSURE EXCEEDS 0.9 INCHES (ADJ.) FOR THE PREFILTER AND 1.5 INCHES (ADJ.) FOR THE FINAL FILTER.


## ROOM PRESSURE MONITOR (RPM), CONTROL SEQUENCE:

- A. RPM-1 SHALL PROVIDE LOCAL ALARMS AND ALARMS AT THE OPERATORS WORKSTATION.

  1. WHEN THE MAGNETIC DOOR CONTACTS ARE OPEN, AUDIBLE ALARMS SHALL BE DISABLED.
- DOOR STATUS AND RECORDED DIFFERENTIAL PRESSURE READINGS SHALL BE LOGGED CONCURRENTLY.
   RPM-2 IS FOR MONITORING PURPOSES, STATUS WILL BE DISPLAYED AT THE OPERATORS WORKSTATION. LOCAL ALARMS SHALL BE DISABLED.
   WHEN THE MAGNETIC DOOR CONTACTS ARE OPEN, DOOR OPEN SHALL BE DISPLAYED AT THE OPERATORS
- WORKSTATION.
  2. DOOR STATUS AND RECORDED DIFFERENTIAL PRESSURE READINGS SHALL BE LOGGED CONCURRENTLY.
  2. SYSTEM GRAPHICS: THE SYSTEM GRAPHICS SHALL DISPLAY ALL POINTS INDICATED ON THE CONTROL SCHEMATIC AND THE FOLLOWING ITEMS:
- AND THE FOLLOWING TIEMS:

  A. ROOM PRESSURE DIFFERENTIAL.

  B. DOOR STATUS

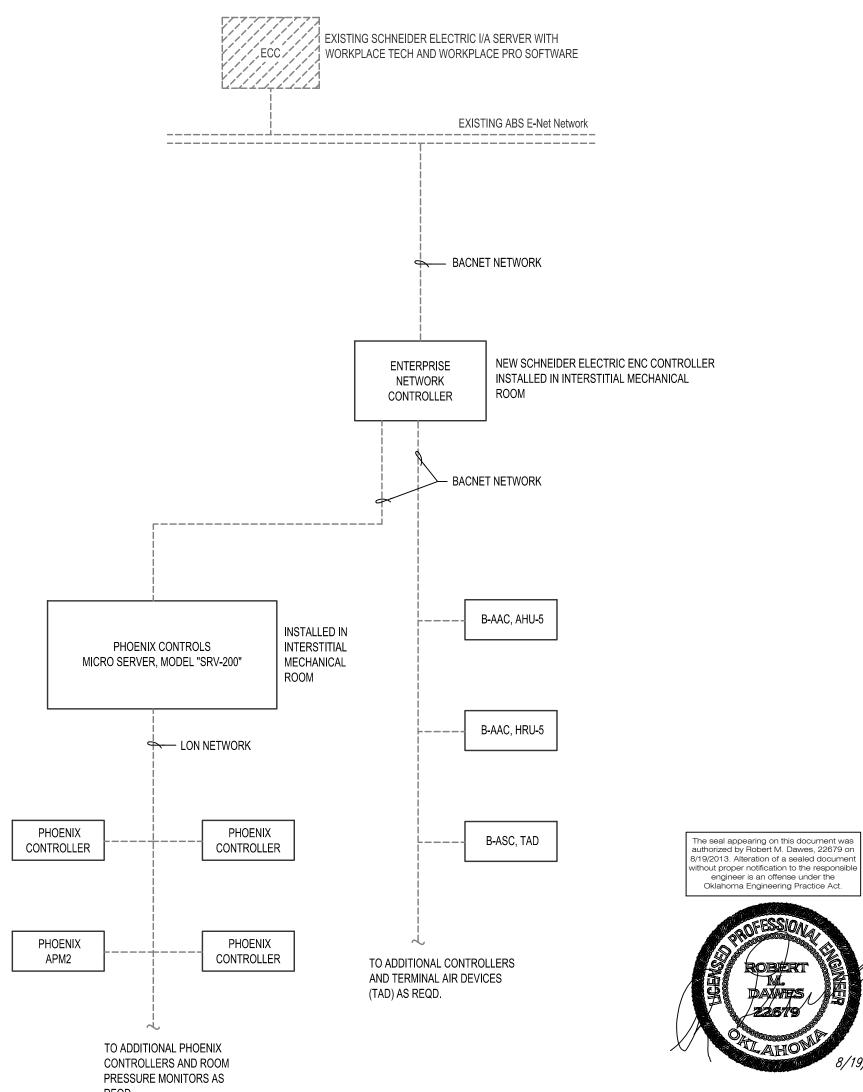

ASBESTOS NOTE:
IF THE EXECUTION OF THIS WORK REQUIRES THE DISTURBING OF ANY SUBSTANCE WHICH APPEARS TO BE ASBESTOS OR WHICH MAY CONTAIN ASBESTOS FIBER, NOTIFY THE OWNER BEFORE CONTINUING WORK AT THE SUSPECT LOCATION. ANY MATERIAL TESTING POSITIVE SHALL BE REMOVED BY THE OWNER BEFORE WORK CONTINUES.

NOTE: EXISTING CONDITIONS SHOWN WERE DERIVED FROM OWNER FURNISHED DRAWINGS AND FIELD OBSERVATIONS. SOME BUILDING FEATURES AND MEP SYSTEMS ARE NOT SHOWN FOR CLARITY. FIELD VERIFY BUILDING CONSTRUCTION. FIELD VERIFY THE LOCATION, SIZE AND QUANTITY OF ALL EQUIPMENT.

E SRIFY

REVISIONS:	DESCRIPTION:	DATE:	

Dept. of Veterans Affairs
Jack C. Montgomery
Medical Center
1011 Honor Height Drive
Muskogee, Oklahoma 74401

ENGINEER:
RMD CONSULTING, LLC 2815 VALLEY VIEW LANE, STE. 214 DALLAS, TX 75234 P: 972-488-8077 F: 972-488-8174 OK REG. ENGINEERING FIRM: 5183

CONSULTANTS:
ARCHITECT: ARCHITECTURAL CONCEPTS, INC. 669 AIRPORT FREEWAY, STE. 300 HURST, TX 76053 P: 817-285-8885 F: 817-285-8021

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APPROVED:	APPROVED: Interior Designer	APPROVED: Safety Manager	APPROVED: Medical Center Director	DRAWING TITLE
APPROVED:	APPROVED:	APPROVED: Infection Control Nurse	APPROVED: Associate Director	HVAC
APPROVED:	APPROVED:	APPROVED: Industrial Hygienist	APPROVED: Chief of Staff	PROJECT NO. 623-
APPROVED:	APPROVED:	APPROVED: President A.F.G.E. 2250	APPROVED: Chief of Engineering Service	BUILDING NO.

<u>note</u> : refer to de Shown for clarity	TAILS AND SCHEMATICS FOR PIPING, '.	VALVES, FITTINGS AND OT	HER APPURTENANCES RI	EQUIRED, BUT NOT	SCALE: NO SCALE
DRAWING TITLE	PROJECT TITLE			DATE	
		REPLACE LABORATORY			8/19/2013
HVAC CONT	ROLS	AIR HANDLING UNITS		SCALE: AS SHOWN	
PROJECT NO.	CONTRACT NO.	DESIGNED BY:	DRAWN BY:	CHECKED BY:	DRAWING NO.
623-11-107	VA256-12-C-0295				MI2.0
BUILDING NO.  CLINICAL  AUTOCAD FILE NAME:		LOCATION			
		Jack C. Montgomery VA Medical Center		DWG. 26 OF 40	